

## Design Development Final Proposal

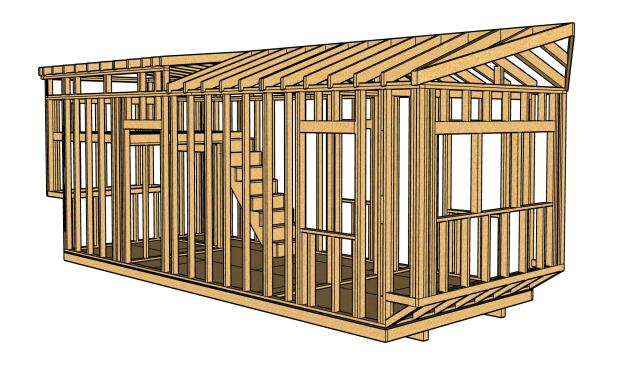

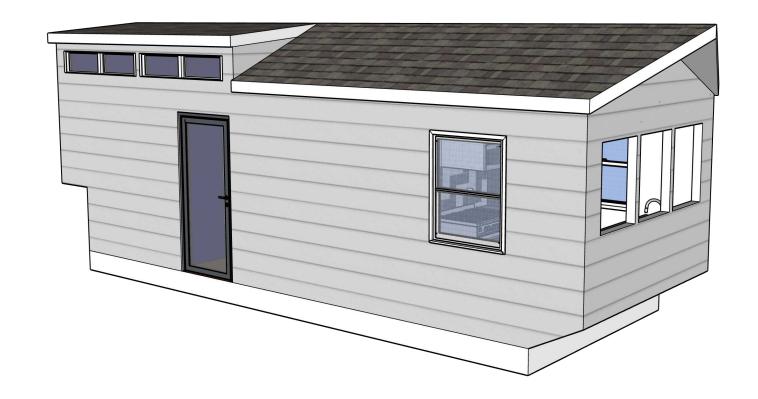

12/2/24

BCS 1116 Studio A - Morning


Professor King

## **Table of Context**

- A1 3D View Cameron Clark
- A2 Front Elevation Vance Andrade
- A3 Back Elevation Grace Ballentine
- A4 Left Elevation Payton Breazeale
- A5 Right Elevation Payton Breazeale
- A6 First Floorplan Jaiden LeBlanc
- A7 Second Floorplan Micah Tindal
- A8 Long Section Front Hayden Cotton
- A9 Long Section Back Hayden Cotten
- A10 Short Section Left Brian Buchanan
- A11 Short Section Right Brian Buchanan
- S1 Front Elevation Left Tyler Haskovec, Tanner Owens
- S2 Front Elevation Center Reid Hodges
- S3 Front Elevation Right Steven Hollis, Yuvraj Singh
- S4 Rear Elevation Left Cohen DeWeese, Hudson Edwards
- S5 Rear Elevation Center Grayson Engels

- S6 Rear Elevation Right Landon Erkintalo Reese Gonazales
- S7 Left Elevation Graham Waldrop Quenton Hubbard
- S8 Right Elevation Graham Waldrop Quenton Hubbard
- S9 Interior Walls Jet Joiner, Calder Farmer
- S10 Loft Floor Bradly Jones, IT
- S11 Roof Banks Wade, Samantha Kornegay
- S12 Front Elevation Sheathing Harrison Sexton
- S13 Rear Elevation Sheathing John Pajak
- S14 Left Elevation Sheathing Todd Loveless
- S15 Right Elevation Sheathing Makayla Martin
- S16 Loft Floor Decking Caroline Tanner
- S17 Roof Sheathing Reese Thompson
- S18 Stairs Nolan Simpson



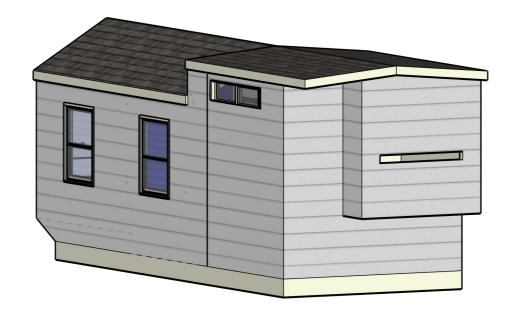



Drawing Title: 3D Model

> Drawn by: Cameron Clark

Design Development Final Proposal


> BCS 1116 Studio A Morning

Professor King

12/2/2024

Scale: NTS



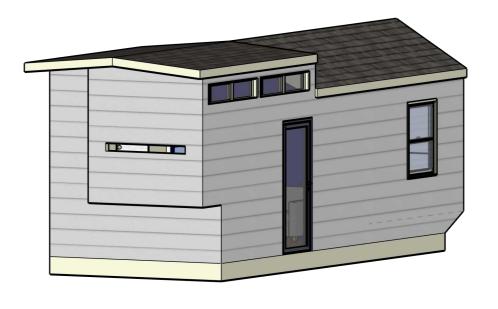





Drawing Title: Elevation 1

Drawn by: Vance Andrade

Design Development-First Proposal


BCS 1116 Studio A Morning


Professor King

10/25/24

Scale: 3/8"=1'



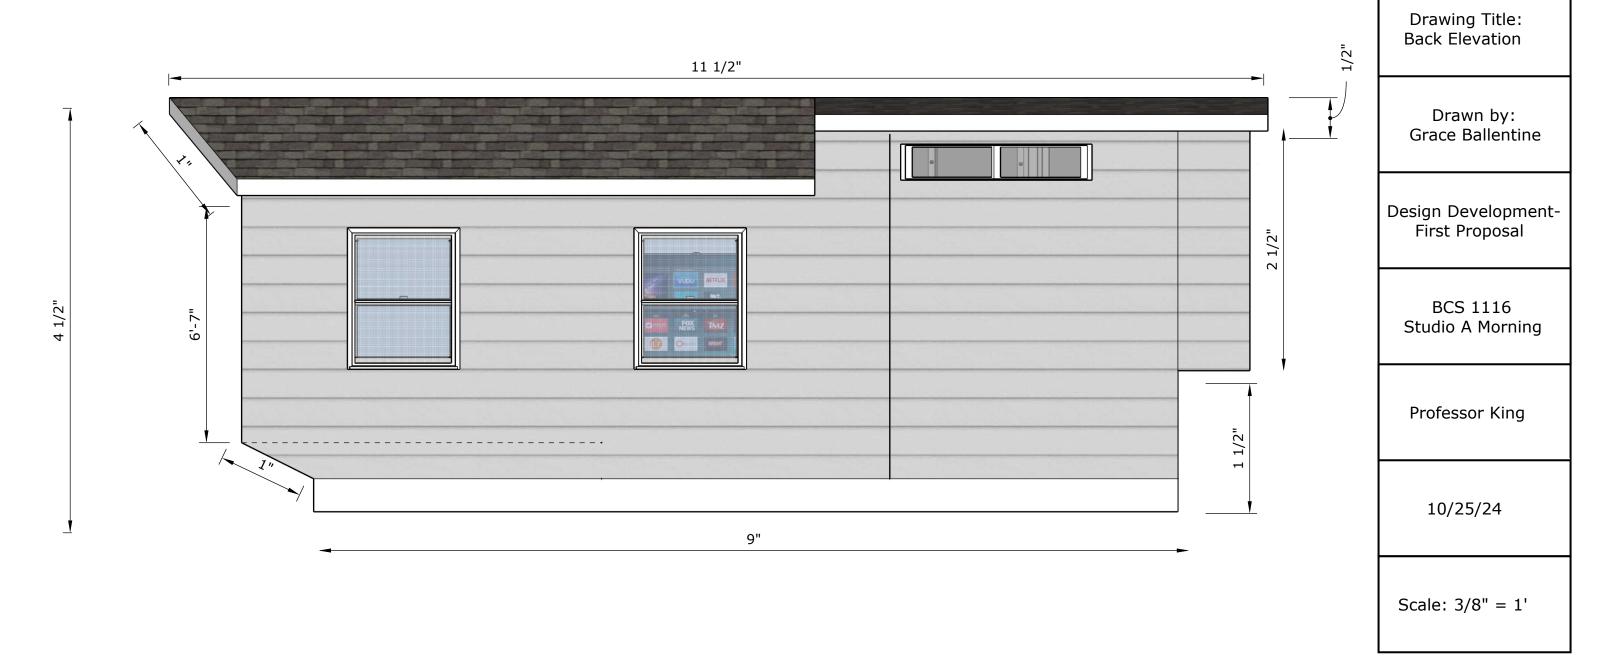

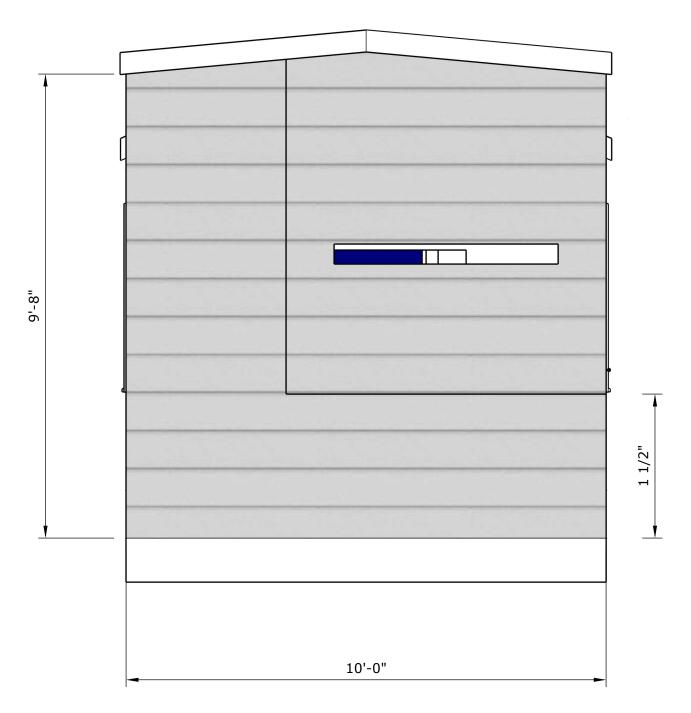



Drawing Title: Left Elevation

> Drawn by: Payton Breazeale


Design Development-First Proposal

BCS 1116 Studio A Morning

Professor King

10/25/24

Scale: 1/2"=1'

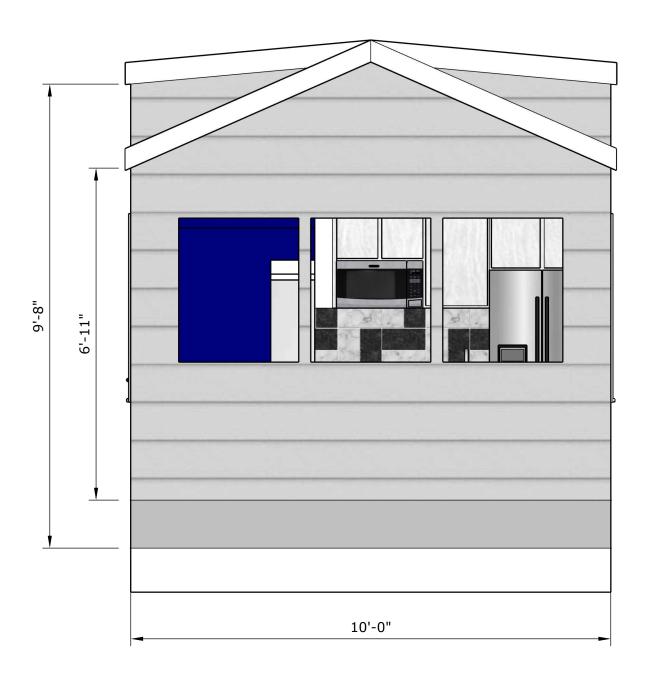



Drawing Title: Right Elevation

Drawn by: Payton Breazeale

Design Development-First Proposal


BCS 1116 Studio A Morning

Professor King


10/25/24

Scale: 1/2"=1'



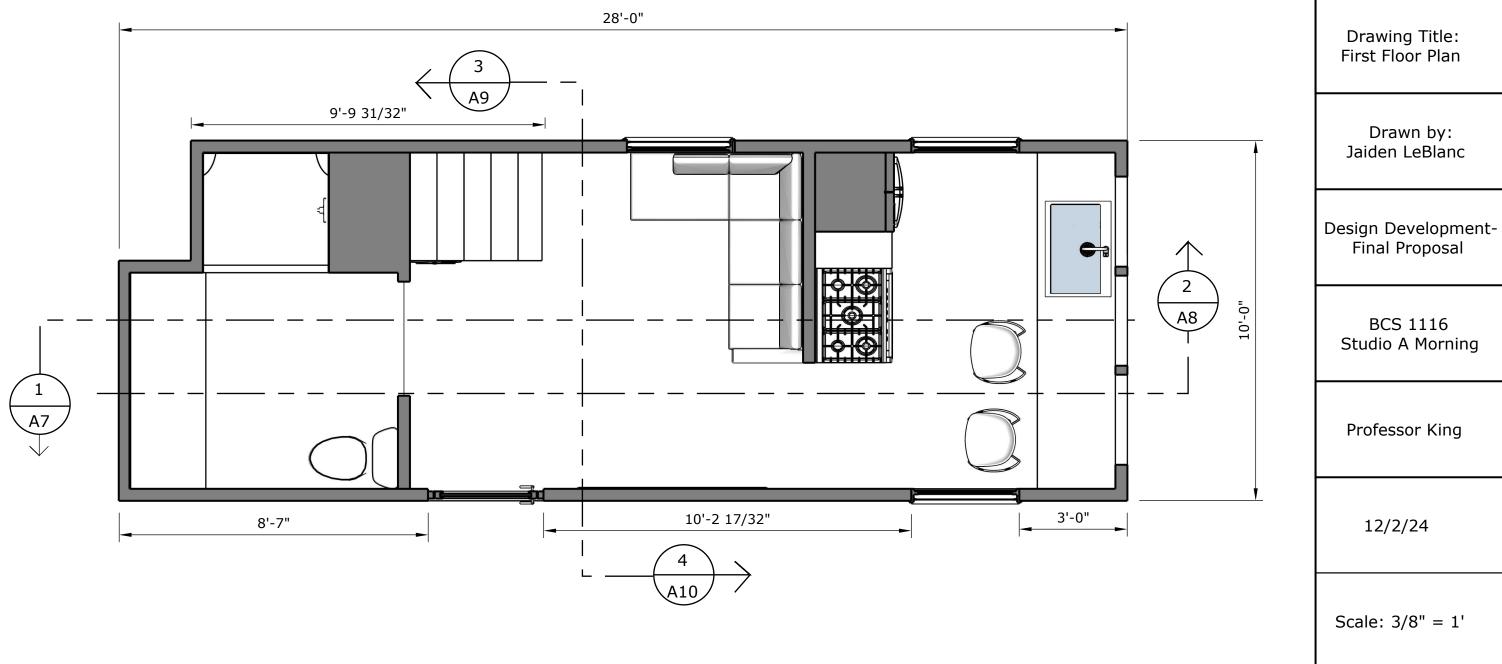



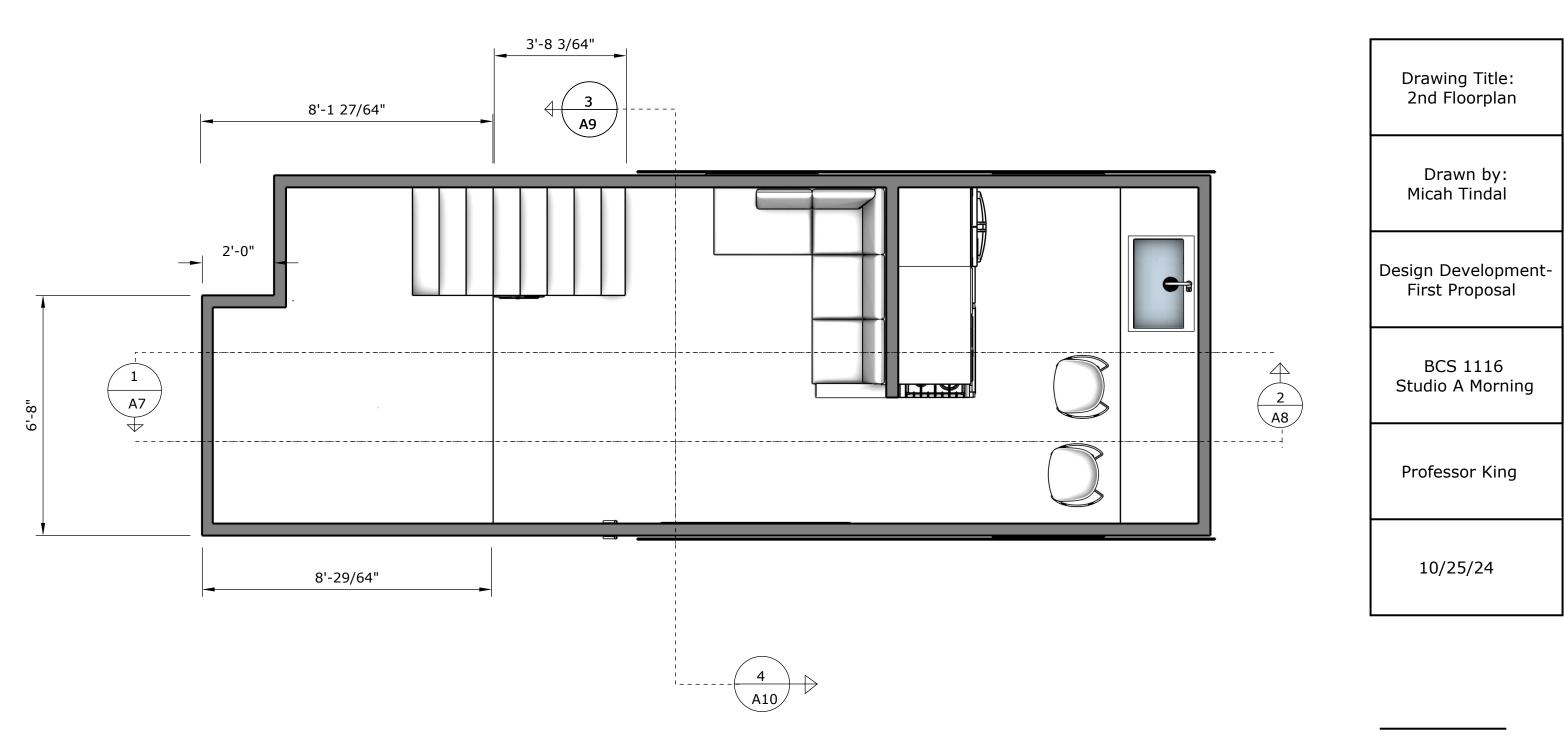





Drawing Title: Front Wall

Drawn by : Hayden Cotton

Design Development-First Proposal

BCS 1116 Studio A Morning

Professor King

12/2/24

Scale: 1/2





Drawing Title: Rear Wall

Drawn by : Hayden Cotton

Design Development-First Proposal

BCS 1116 Studio A Morning

Professor King

12/2/24

Scale: 1/2





Drawing Title: Short Section Left Wall

Drawn by: Brian Buchanan


Project #9 As-Built Drawings & Assembly

> BCS 1116 Studio A Morning

Professor King

12/1/2024

Scale: 1/2"

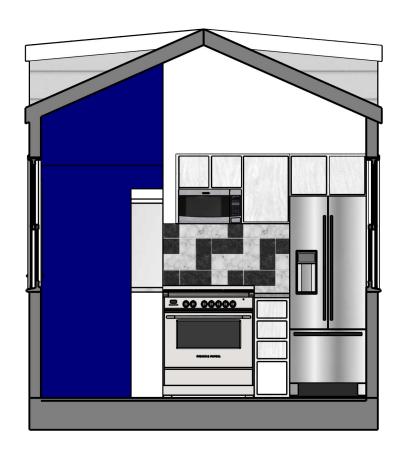



Drawing Title: Short Section Right Wall

> Drawn by: Brian Buchanan


Project #9 As-Built Drawings & Assembly

> BCS 1116 Studio A Morning

Professor King

12/1/24

Scale: 1/2"

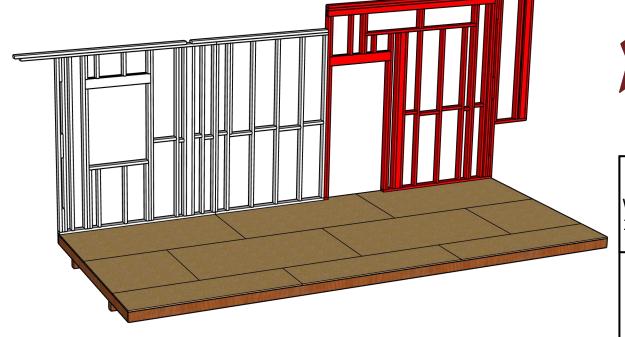






Front Elevation Wood Framing Section 1 Left

Drawn by: Tyler Haskovec, Tanner Owens

	QTY.	Та	ask	< List	Design Development-
		-Organize the maplates and studs	teri	als and begin cutting	Final Proposal
		-Mark stud placer to the plates		t 16" and assemble and attach header	BCS 1116 Studio A Morning
		C	ut	List	
	5 3 3	2x4x 9'-4 3/4" 2x4x 9'-8 17/64	1	2x4x 11'-8 1/2"	Professor King
9-4 3/4	3 6 4 2	"2x4x 2' 3/4" 2x4x 1'-0" 2x4x 6'-8 1/4" 2x4x 6'-6 1/2"	2 1 3 1	•	11/30/24
	2 1	2x6x 3'-5 1/2" 2x4x 6'-6"		,	Scale: 1/2"-1'
		Bill o	f N	1aterials	
	11 7 2 2 7	2x4x 10'-0" 2x4x 8'-0" 2x6x 4'-0" 2x4x 12'-0" 2x4x 4'-0"			S. 01

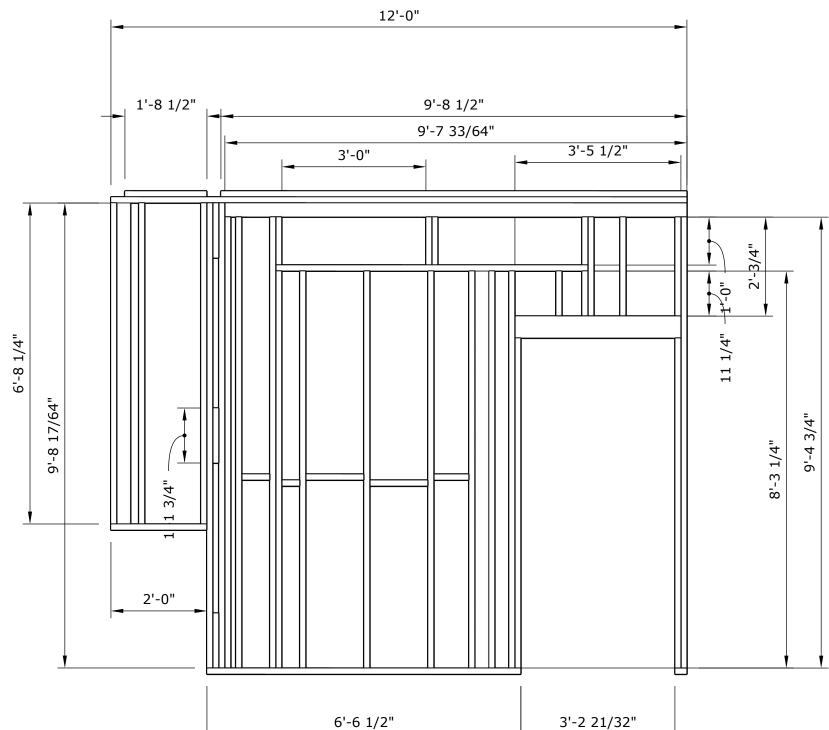

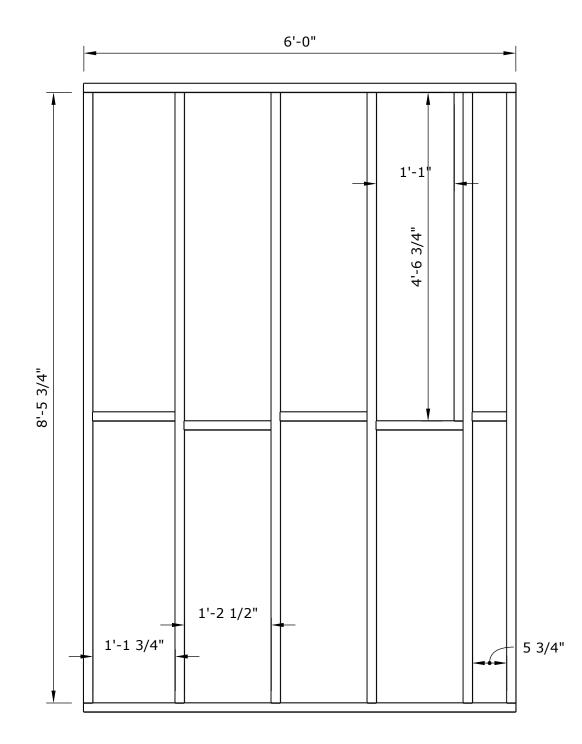

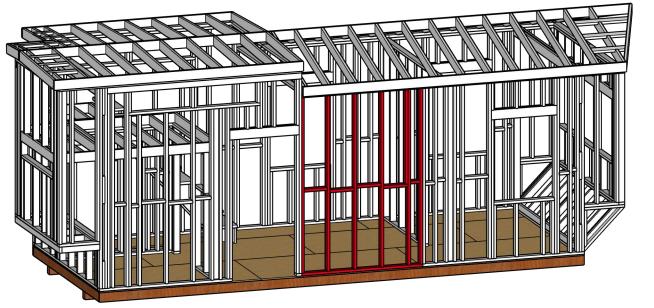





Drawing Title: Front Elevation Wood framing section 2 Center

Drawn by: Reid Hodges John McGinnis

QTY.	TASK LIST	Design Development-
	-Organize materialsCut boards to length.	As-Built
	-Assemble wall.	BCS 1116
	CUT LIST	Studio A Morning
6 2 1 1 3	2x4x 8'-5 3/4" 2x4x 6'-0" 2x4x 4'-6 3/4" 2x4x 1'-1 3/4" 2x4x 1'-2 1/2"	Professor King
1	BILL OF MATERIALS	12/01/24
6 4	2x4x 10'-0" 2x4x 8'-0"	Scale: 3/4" - 1'

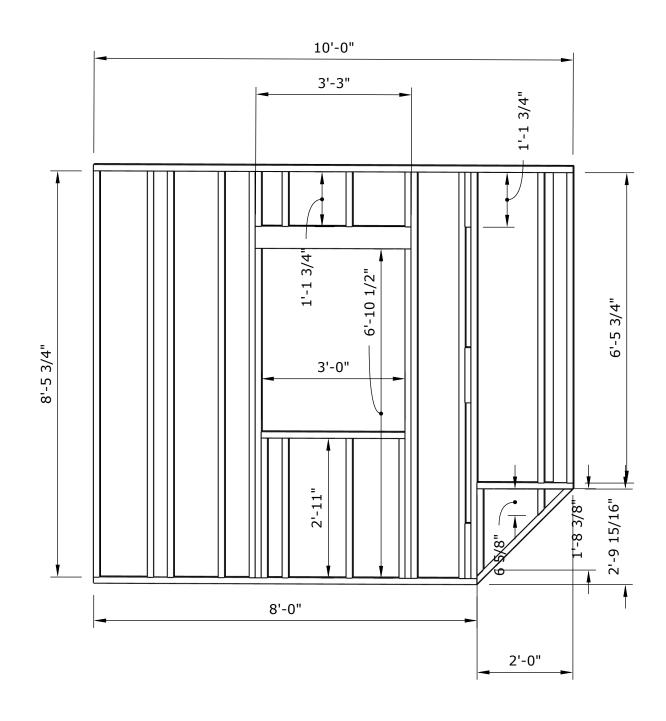

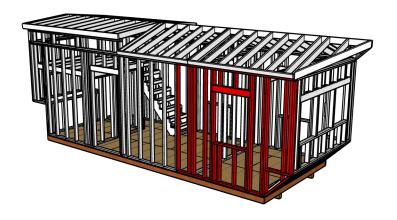




Drawing Title: Front Elv. Wood Frame Section 3(right)

QTY.	Task List	Drawn by: Stephen Hollis
	-Organize the materials and begin cutting plates and studs	Yuvraj Singh
	-Mark stud placement and assemble to the plates -Put in window studs and headers	Design Development- First Proposal
	-Cut angle for bump-out and assemble	
	Cut List	BCS 1116 Studio A Morning
8	2x4x 8'-5 3/4"	_
4	2x4x 2'-11"	
2	2x4x 6'-10 1/2"	Professor King
1	2x4x 3'-0"	Troressor King
7	2x4x 1'-1 3/4"	
1	2x4x 8'-0"	
1	2x4x 10'-0"	10/25/24
2 3	2x4x 2'-9 15/16"	
3	2x4x 6'-5 3/4"	
1	2x4x 1'-8 3/8"	
1	2x4x 6 5/8"	Scale: 1/2=1'0"
1	2x4x 2'-0"	
2	2x6x 3'-3"	
	Bill of Materials	S.03
12	2x4x 10'-0"	3.03
12	2x4x 8'-0"	
		I .

2x6x 10'-0"

1

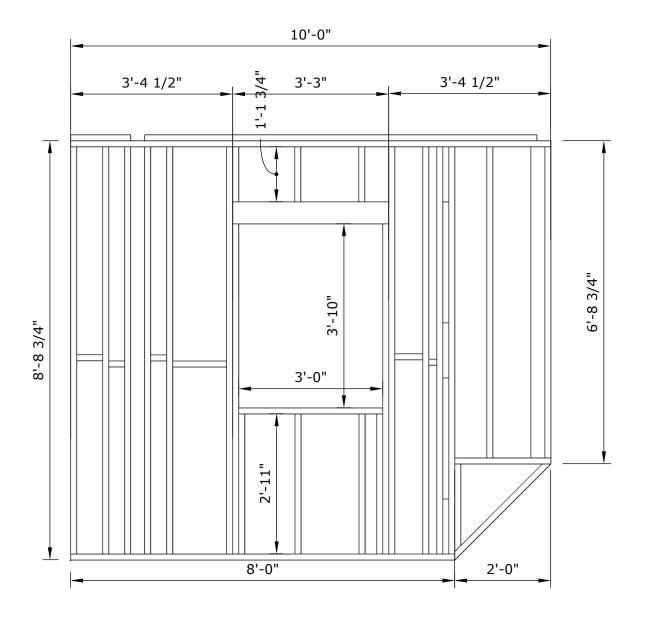



Qty.	Task List		
	<ul> <li>Gather all wood and cut to correct measurements</li> <li>Mark 16" on center on soleplate and topplate</li> <li>Fasten boards to marked locations</li> </ul>		
	Cut List		
13	2x4 8′5 3/4″		
4	2x4 1'1 3/4"		
	2x4 6′5 3/4"		
3 1	2x4 2' 2x4 2'9 15/16" angled cut ** 2x4 2' 11" 2x4 6'10 1/2" 2x4 1'1 3/4" 2x4 6 5/8" angled cut ** 2x4 1'9 7/8" angled cut ** 2x4 10'		
1			
4			
2			
2 3 1			
1			
1			
1			
2	2x6 3′ 3″		
1	2x4 8'		
	Bill of Materials		
9	2x4 8'		
14	2x4 10'		
1	2x6 8'		



Drawing Title: Rear Left

Drawn by: Cohen Deweese & Hudson Edwards


Design Development-Second Proposal


BCS 1116 Studio A Morning

Professor King

12/2/24

Scale:1/2"=1'

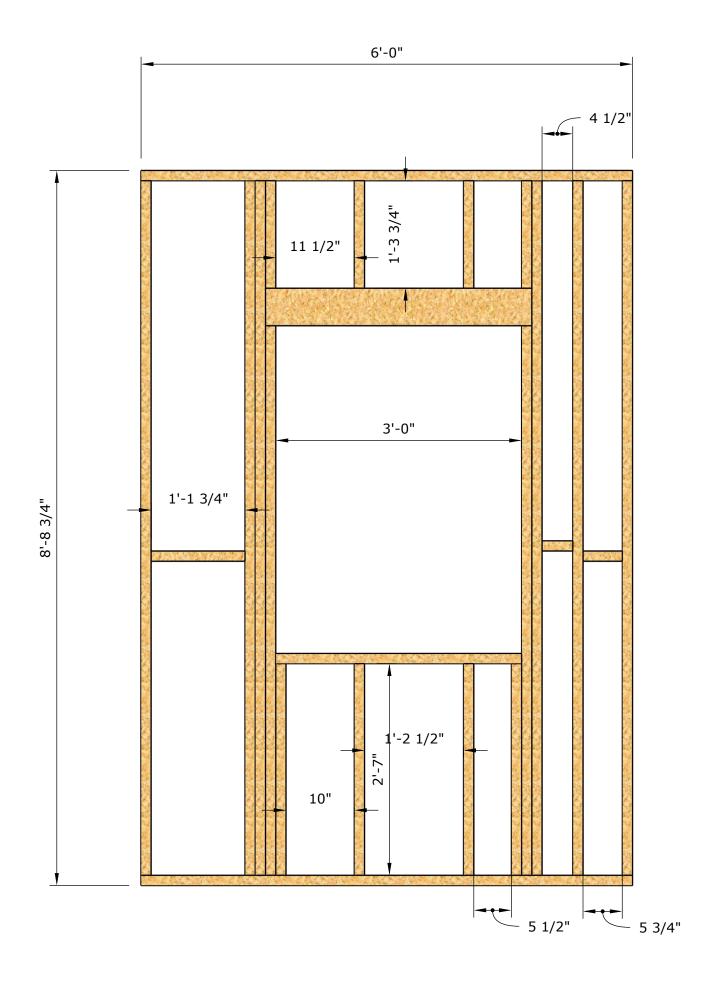

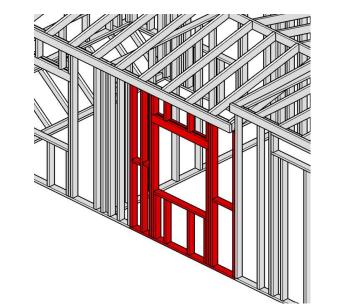

**10** 10' 2X4's 8'-2x6





Rear Elv. Wood Framing Section 2 (Center)

> Drawn by: Dominic Fay

QTY:	Task List	Design Development- First Proposal
	<ul> <li>Prepare and organize materials</li> <li>Cut materials to appropriate size</li> <li>Measure and mark studs, 16"</li> </ul>	BCS 1116 Studio A Morning
	<ul> <li>on center going left to right taking account for the window</li> <li>Begin nailing in appropriate position</li> </ul>	Professor King
6	Cut List 8'5 3/4" 2X4	12/2/24
4 2 4 1 1 2	1'3 3/4" 2X4 6' 8 1/2" 2X4 2'7" 2X4 2' 2X4 6' 2X4 3'3" 2X6	Scale: 1/2"=1'
1 1 1	5 3/4" 2X4 4 1/4 2X4 1' 13/4" 2X4	
	Bill Of Materials	S. 05

(View of the wall from the inside)

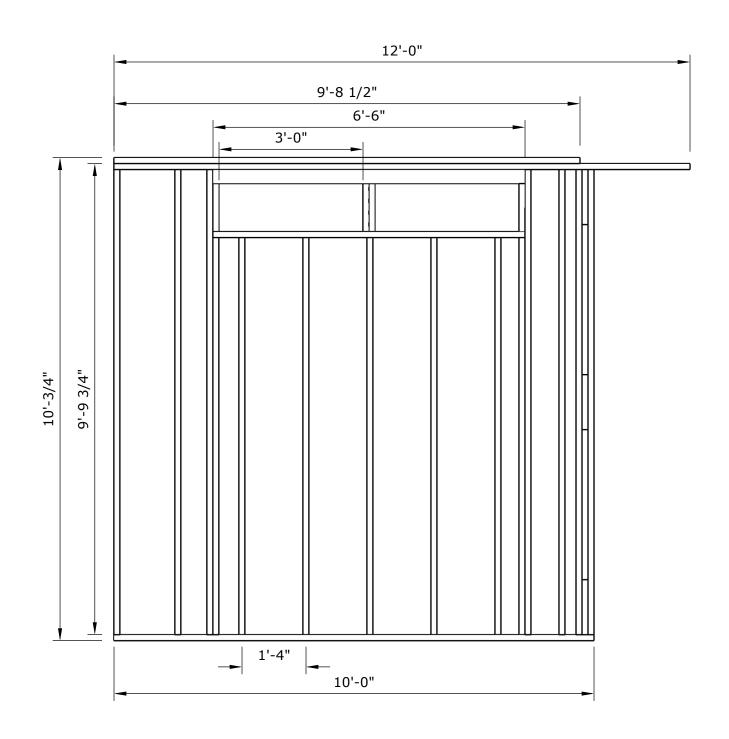


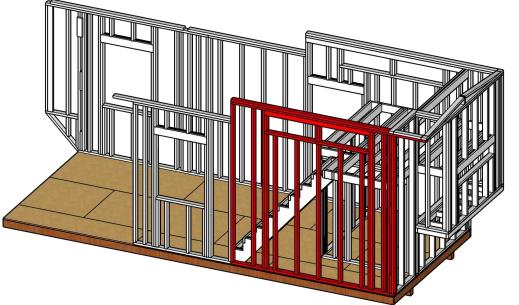




Drawing Title:

		Rear Elevation Section 3  Drawn by:
QTY.	Task List	Landon Erkintalo & Reese Gonzales
	-Organize the materials and begin cutting the plates and studs -Mark the spacing on plates	Design Development- First Proposal
	-Make sure studs are place correctly and begin fastening them to the plate -Align window and adjust studs	BCS 1116 Studio A Morning
	-add blocking between studs  Cut List	Professor King
7 4 7 1	2x4x9'-9 3/4"	10/25/24
1 1 3 1	2x4x12' 2x4x9'-8 1/2" 2x4x1-1' 3/4" 2x6x6'-6"	Scale: 1/2"-1'
	Bill of Materials	
15 1 1	2x4x10' 2x4x12' 2x6x10'	3. UU

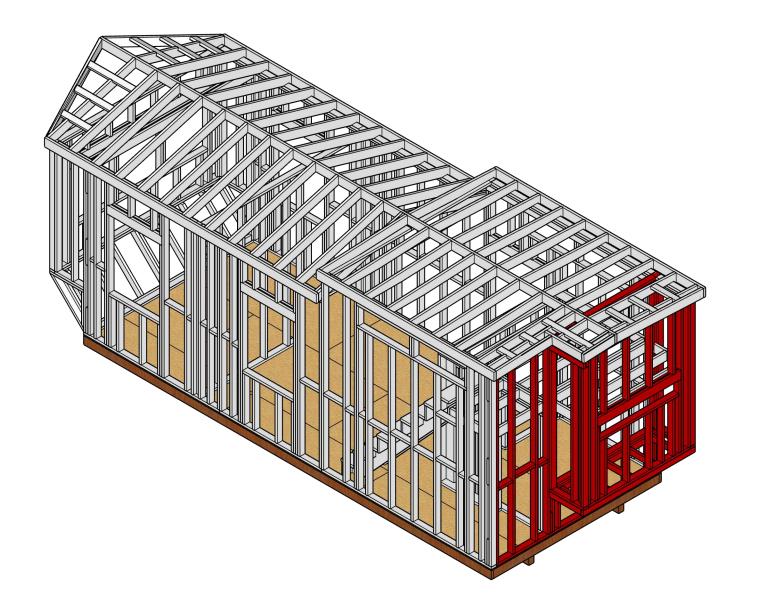

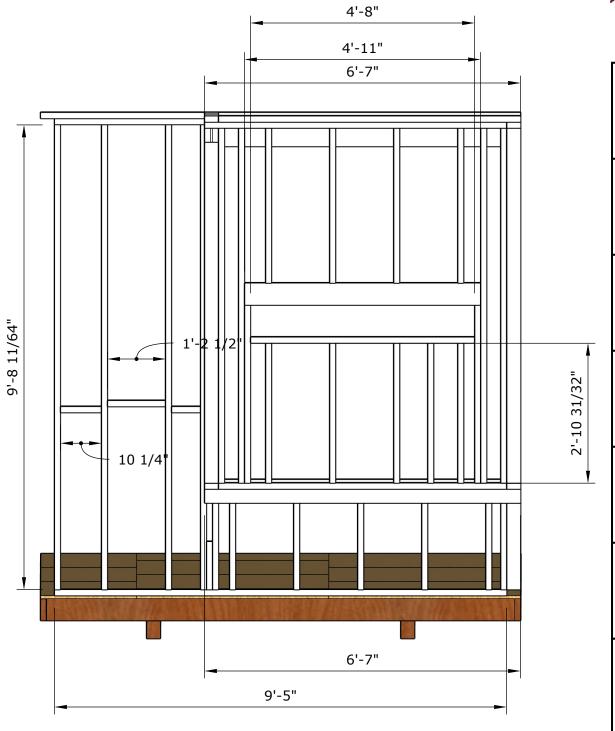



Left Elv. wood framing

Drawn by: Nolan Simpson Quenton Hubbard


As Built Drawings & Assembly


BCS 1116 Studio A Morning

Professor King

12/2/24

Scale: 1/2" = 1'-0"

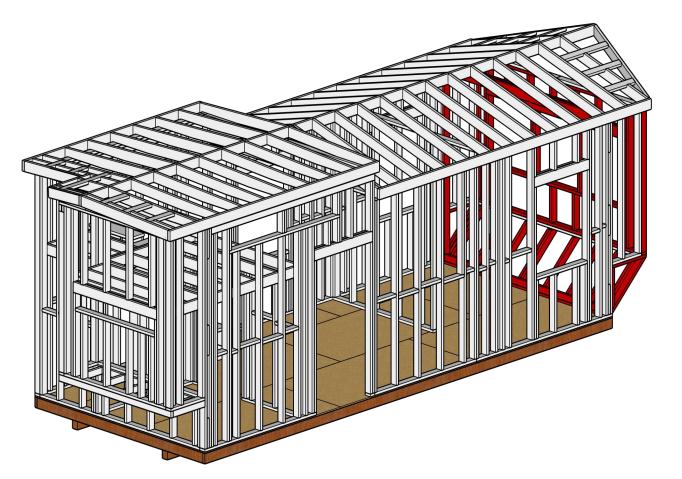

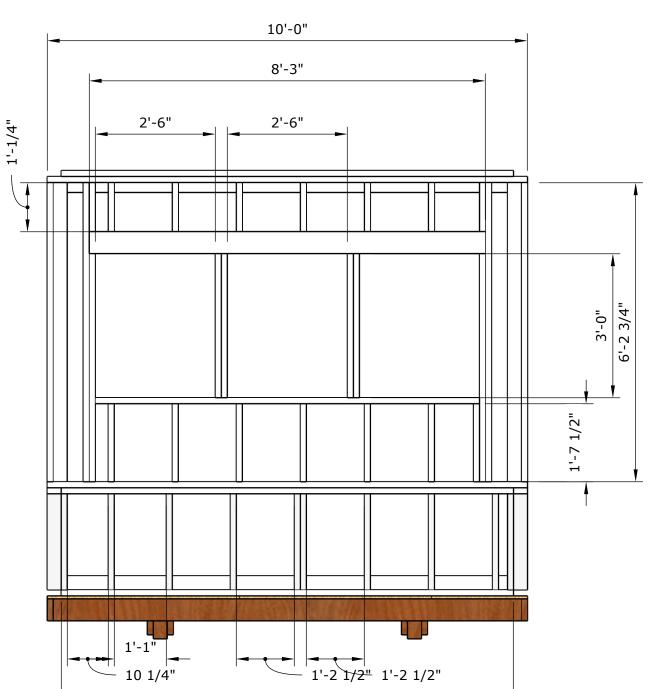

9'-5"



Right Elv. wood framing

Drawn by: Nolan Simpson Quenton Hubbard


As Built Drawings & Assembly


BCS 1116 Studio A Morning

Professor King

12/2/24

Scale: 1/2" = 1'-0"

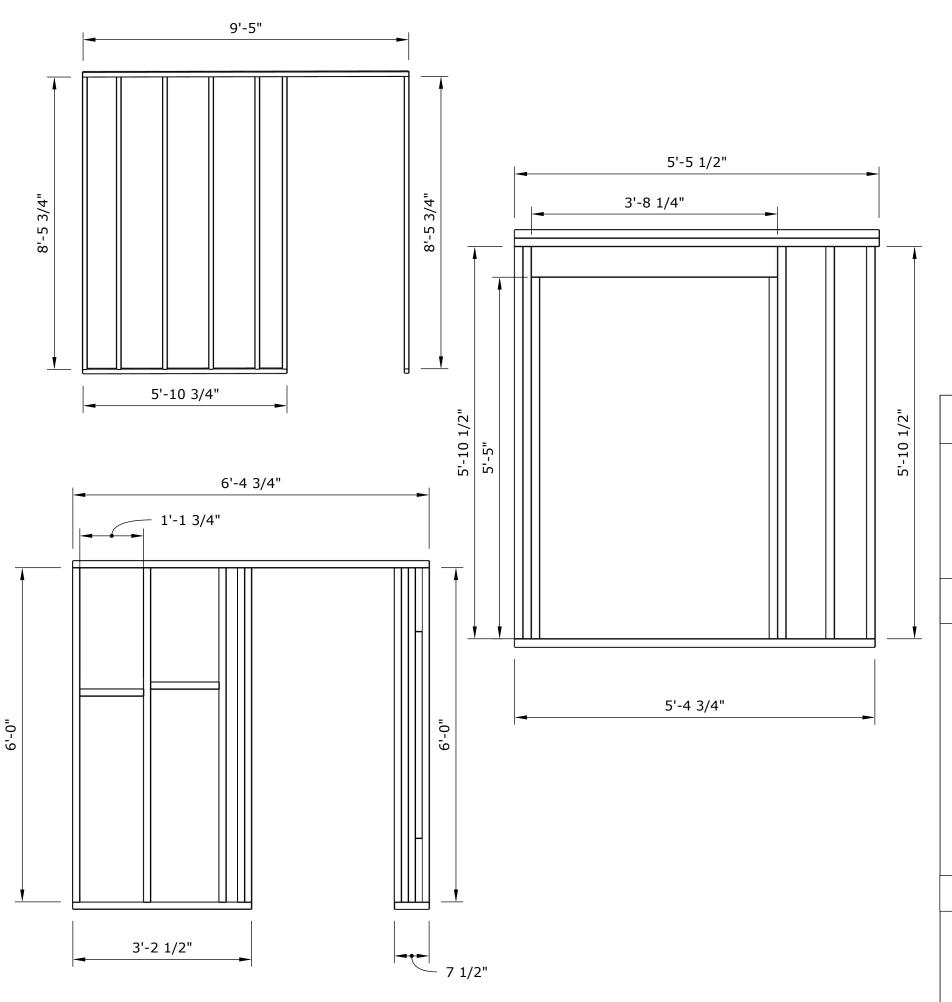

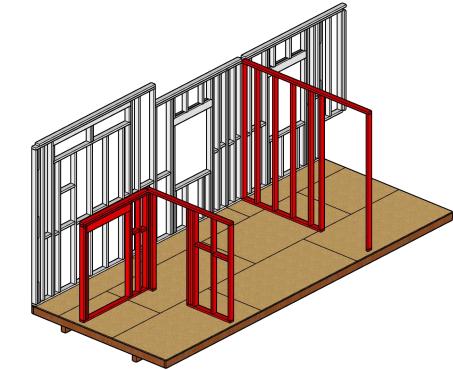




Interior Walls

QTY.	Task List -Organize the materials and begin cutting	Jett Joiner, Calder Farmer
	plates and studs -Mark stud placements and assemble to the plates -Assemble bump-out and attach header	Project 9 As- Built Drawings & Assembly
7 9	Cut list 2x4x 8'-5 3/4" 2x4x 6'-0"	BCS 1116 Studio A Morning
1 1 2 1	2x4x 7 1/2" 2x6x 3'-8 1/4" 2x4x 5'-5 1/2" 2x4x 6'-4 3/4" 2x4x 5'-10 3/4"	Professor King
1 2 5 2 1	2x4x 9'-5" 2x4x 1'- 1 3/4" 2x4x 5'-10 1/2" 2x4x 5'- 5" 2x4x 3'- 1/2" 2x4x 5'-4 3/4"	12/2/24
1	Bill of Materials	Scale: 3/4"-1'
8 26	2x4 10'-0" 2x4 8'-"	
1	2x6 8'-0"	<b>S.09</b>



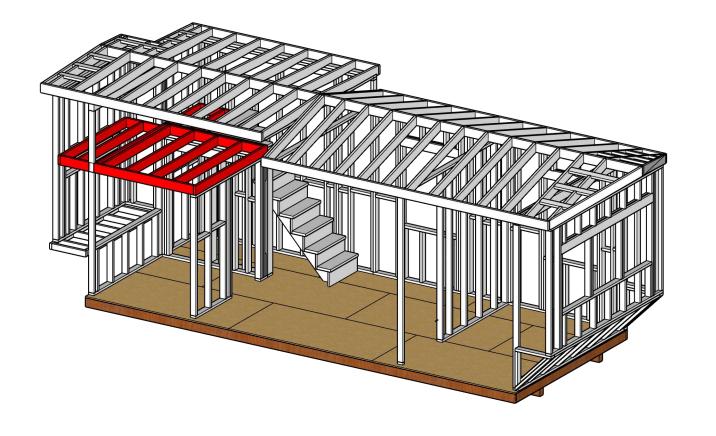

Drawing Title: Loft Floor Wood Framing

Drawn by: Brady Jones I'terrious Hunter

Design Development-First Proposal

BCS 1116 Studio A Morning



-Organize all materials for the loft and begin measuring and cutting the needed 2x6's.

-Lay all cut boards on the ground in the order and spacing(16 inch off center) as

-Once all the studs are correctly spaced begin fastening them to the running boards.

Professor	King
-----------	------

12/1/24

Scale 1/2" = 1'


QTY.	Cut List	QTY.	Cut List
65	2X6 - 6'-1/4"	3	2X6 - 5' -6 3/4"
1	2X6 - 2'-6 3/4"	3	2X6 -2' -10 3/4"
1	2X6 - 5'-8 15/16"	1	2X6 - 6'-0"
2	2X6 - 1'- 10 1/2	1	2X6 - 6'-4 3/4"
			_

Ύ.	Bill of Materials	S. 10
	2X6- 8'	
	2X6- 16'	

1'-10 1/2"	5'-8 15/16"	2'-10 3/4"
5'-6 3/4"	6'-1/4"	2'-6 3/4"

6'-0"

6'-4 3/4"

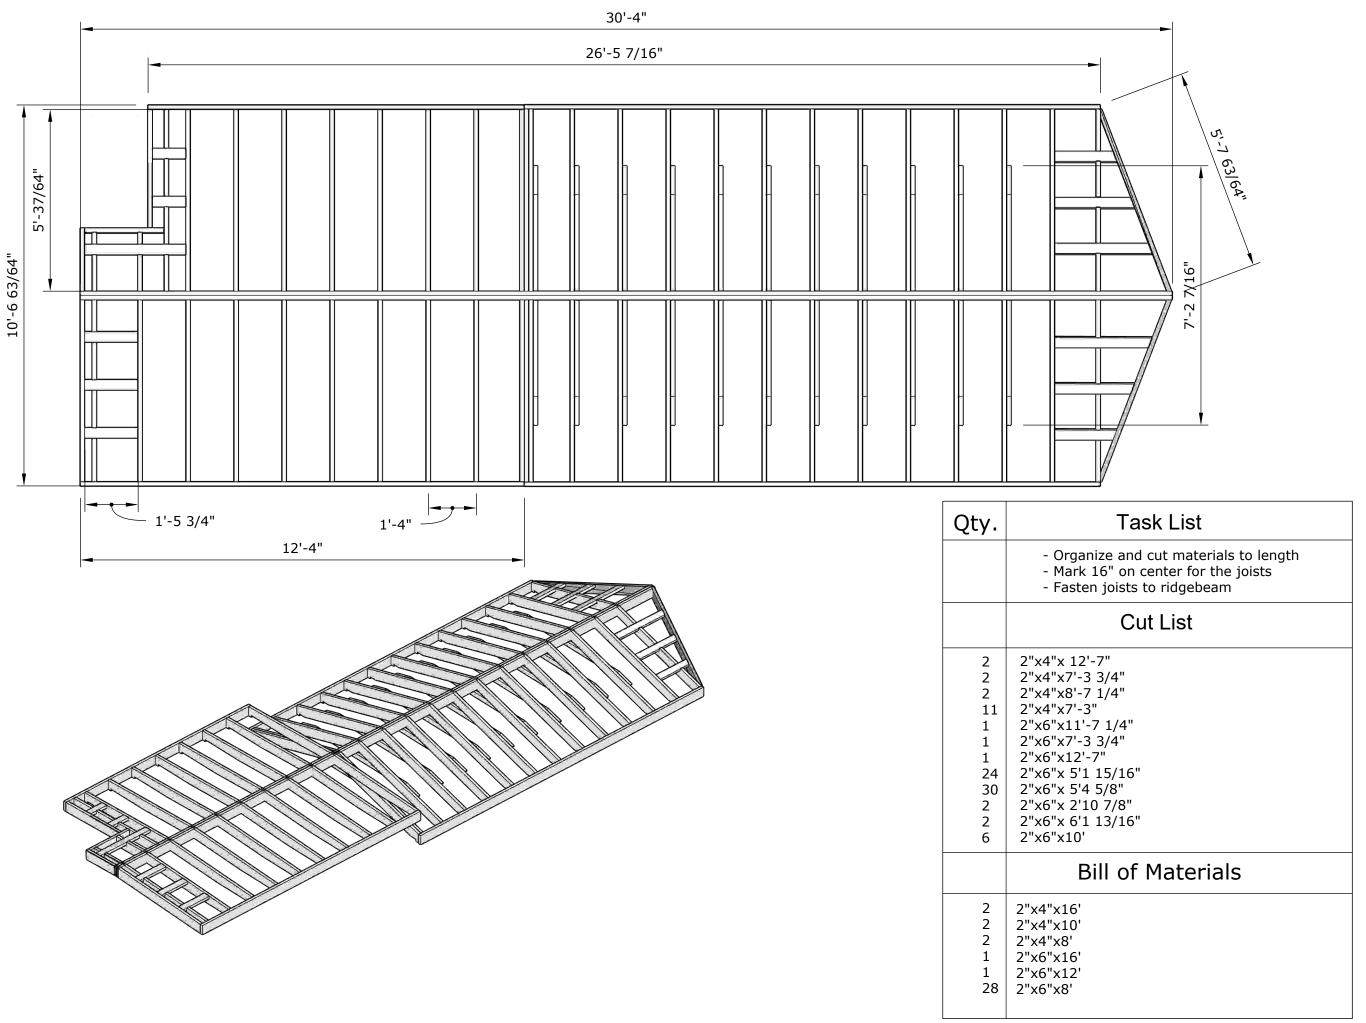



Drawing Title: As-Built: Roof Plan

Drawn by: Banks Wade


Structural Frame Fabrication

BCS 1116 Studio A Morning

Professor King

11/22/24

Scale: 3/8" and 1/4"

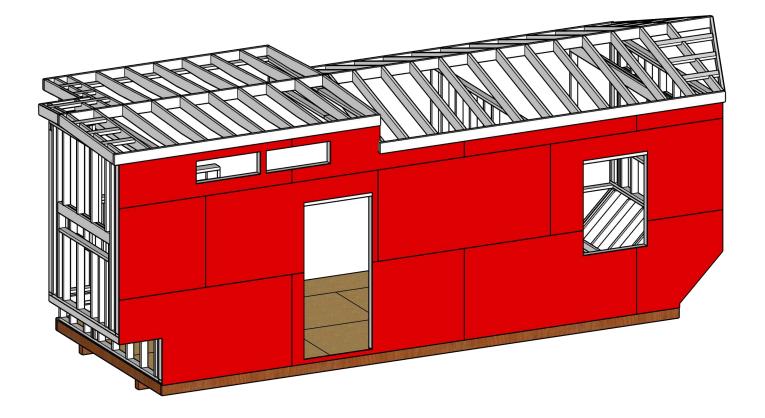



Front Elevation Sheathing

	1. Gather all of the materials and cut them to length. 2. Lay out the sheathing boards as needed and mark board placement before nailing. 3. Nail all boards in correct order	
QT.	CUT LIST	
6 2 2 2	4'x 8' x 1/2" 4'x 4' x 1/2" 2'1 3/8"x 8 x 1/2" 10 7/8" x 8'x1/2"	
QT.	BILL OF MATERIALS	
9	4' x 8' x 1/2"	


Harrison Sexton

Design DevelopmentFirst Proposal

BCS 1116
Studio A Morning

Professor King

10/25/24
Scale: 1/4"=1'

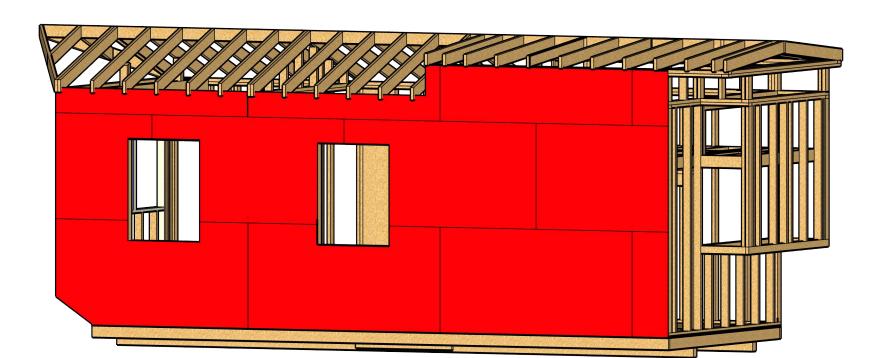




Back Elevation

Sheathing

	TASK LIST  1. Gather all of the materials and cut them to length.  2. Lay out the sheathing boards as needed and mark board placement before nailing.  3. Nail all boards in correct order		
QT.	CUT LIST		
5 1 1 3 2	4x8'x.5" 4x4'x.5" 4x5'x5x15/16" 2x'1x1/8"x8' 4'x 1'x5'15/16		
QT.	BILL OF MATERIALS		
12	4x8x1/2"		


John Nolan Pajak Design Development-First Proposal BCS 1116 Studio A Morning Professor King 11/29/24

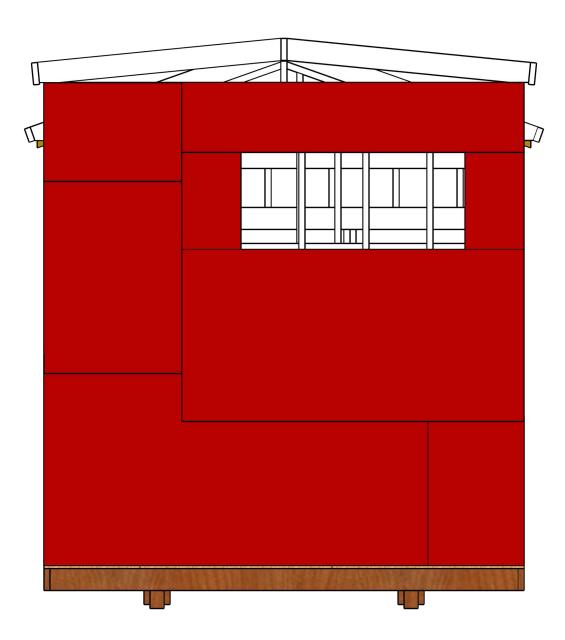




	TASK LIST		
	<ol> <li>Gather all of the materials and cut them to length.</li> <li>Lay out the sheathing boards as needed and mark board placement before nailing.</li> <li>Nail all boards in correct order</li> </ol>		
QT.	CUT LIST		
1 1 1 1 1 1	1'10 1/2", 2'10 1/2" 4',2'10 1/2" 4',7' 1 1/2" 3'3/4",2' 1'10",7'1 1/2" 4',7' 1 1/2"	10 1/2",5' 1 1/2"	
QT.	BILL OF MATERIALS		
5	4'x8'x1/2"		
	Scale 1/2"=1'		

Todd Loveless
Design Development- First Proposal
BCS 1116 Studio A Morning
Professor King
12/2/24

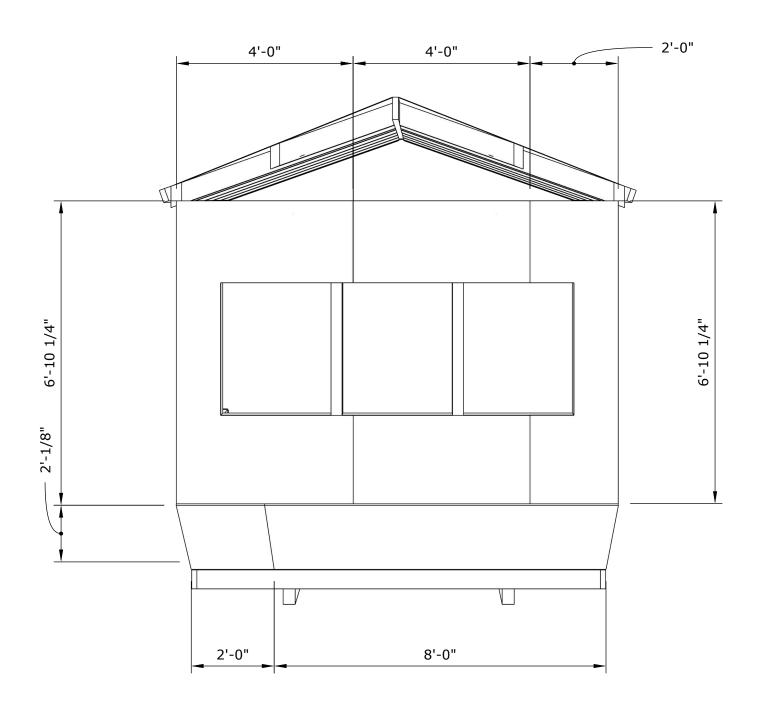

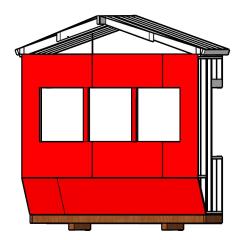





Right Elevation	
Sheathing	

Drawn by: Makayla Martin

QTY.	Task List	Design Development-
	-Organize the materials -Cut Necessary plywood pieces	Final Drawing
	-Stagger pieces along side wall and nail them into place making sure they are flush	BCS 1116 Studio A Morning
	- Cut out extra hangover pieces from inside windows	Professor King
	Cut List	
2	6'-10 1/4"- 4'- 1/2" 6'-10 1/4"-2'-1/2"	12/2/2024
1 1	6'-10 1/4"-2'-1/2" 2'-1/8"-2'-1/2"	C 1 /2    1
1	8'-2'1/8"-1/2"	Scale: 1/2"-1'
	Bill of Materials	
5	4'-8'-1/2"	

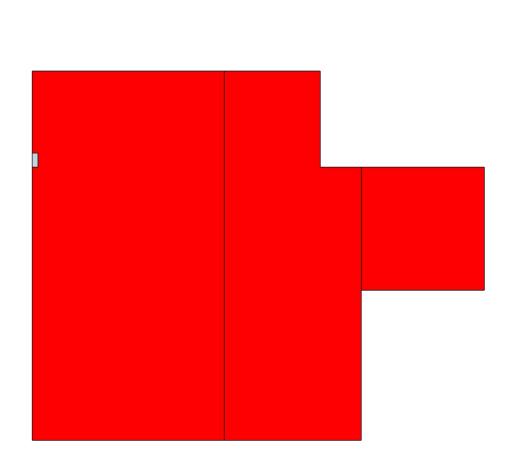

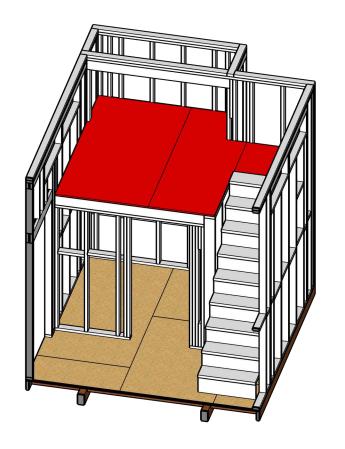

	Task List
	-Organize all materials and begin cutting plywood to cut list -Cut notches in plywood to fit around studs. -Lay plywood making sure it is flush and nail it in.
	Cut List
1 1 1	4' x 7'-8 1/4" Plywood 2'-10 1/4" x 7'-8 1/4" Plywood 2'-6 3/ " x 2'-6 3/4" Plywood
	Bill of Materials
3	4' x 8' Plywood



Drawing Title: Loft Floor Decking

Drawn by: Caroline Tanner


Design Development-First Proposal


BCS 1116 Studio A Morning

Professor King

12/2/24

Scale: 1/2"=1'

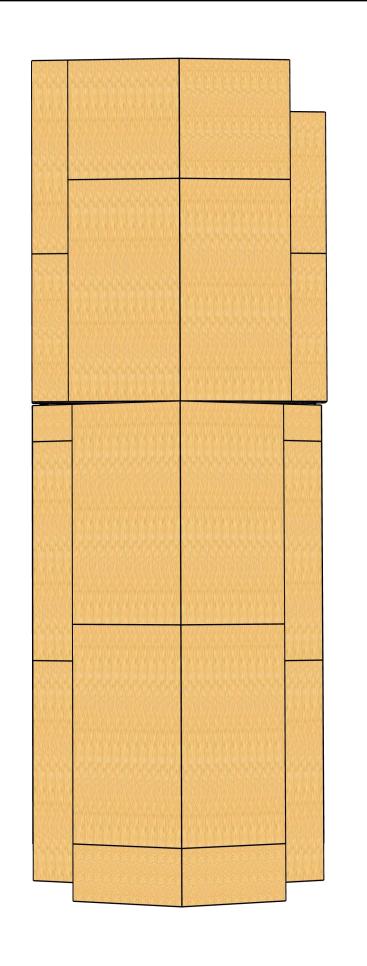

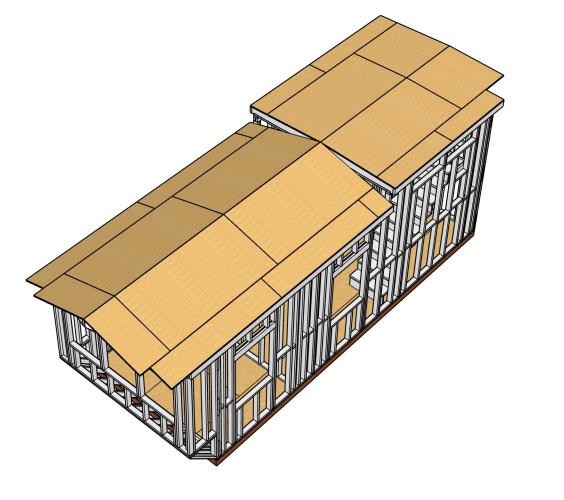

QTY:	Task List
	-Cut plywood to dimensions -Lay plywood down
	Cut List
4 2 4 2 2 1 1 2	1'6" X 8' 1'6" X 1'4" 4' X 8' 4' X 2' 3/4" 5'4" X 1'3 1/2" 5'1 1/2" X 1'3 1/2" 7' X 1'3 1/2" 4'4" X 4'
	Bill of Materials
14	Sheets of plywood



Drawing Title: Roof Sheathing


Drawn by: Reese Thompson

Design Development-Final Proposal

BCS 1116 Studio A Morning

Professor King

12/2/24

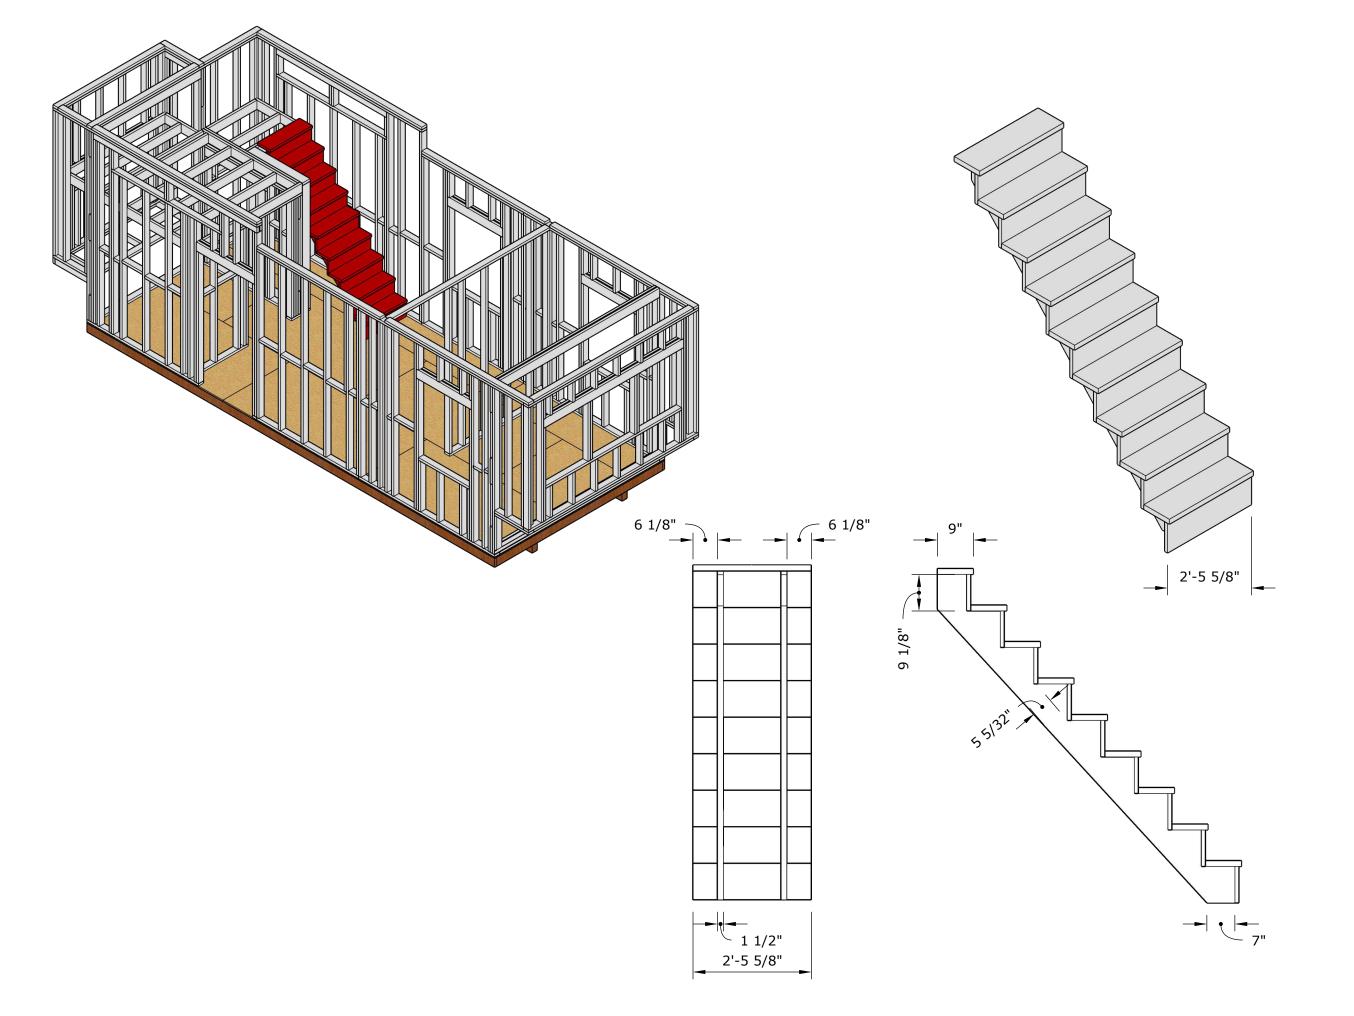



Stair Unit

Drawn by: Nolan Simpson

As Built Drawings & Assembly

BCS 1116 Studio A Morning

Professor King

02/12/24

Scale: 1/2" = 1'-0"